

. ALL DIMENSIONS ARE IN MILLIMETERS UNLESS OTHERWISE STATED.

- 2. THIS DRAWING SHALL BE READ IN CONJUNCTION WITH ARCHITECTURAL, PUBLIC HEALTH, ELECTRICAL AND STRUCTURAL DRAWINGS.
- 3. PIPES SHALL BE HEAVY DUTY GI PIPE CLASS "B" CONFORMING TO IS 1239.
- 4. UNDERGROUND PIPE SHALL BE COATED AND WRAPPED AS PER IS: 10221 WITH "PYPKOTE" WRAPPING COATING MATERIAL OF 4mm THICK.
- 5. SLUICE VALVE SHALL BE CONFORMING TO IS: 780.
- 6. 5. THE DEPTH OF UNDERGROUND PIPE SHALL BE DECIDED AT SITE AS PER THE SITE CONDITION TO AVOID FOULING WITH OTHER SERVICES SUBJECT TO THE TOP OF THE U/G PIPE IS MINIMUM 1M BELOW FROM THE FGL.
- 7. MINOR CHANGES IN THE PIPE ROUTING SHALL BE MADE TO SUIT SITE LOCATIONS WITHOUT EFFECTING DESIGN ASPECTS.
- 8. MINOR CHANGES IN THE HYDRANT LOCATION SHALL BE MADE TO SUIT MACHINE/ EQUIPMENT REQUIREMENT WITHOUT EFFECTING DESIGN ASPECTS.
- 9. ANY DISCREPANCIES ARE TO BE BROUGHT TO THE ATTENTION OF THE ENGINEER AND RESOLVES AT TENDER STAGE BEFORE COMMENCEMENT OF ANY WORK. NO FURTHER CLAIMS SHALL BE ENTERTAINED THEREAFTER.

### LEGENDS:-

SR. NO.	SYMBOL	DESCRIPTION
1.		1500 GI CLASS 'B' HYDRANT PIPE
2.	SH	SINGLE HEADED
3.	<b>@</b> •	SINGLE HEADED YARD HYDRANT
4.	HU	FIRE HOSE BOX WITH SET OF HOSE
5.	<b>■</b> ∄	BRANCH PIPE & NOZZLE
6.		RUBBER FIRE HOSE (ø63mm,2Nos, 15m LENGTH)
7.		HOSE REEL, Ø20MM, 30M LONG
8.	M	GATE/SLUICE VALVE WITH CHAMBER
9.	<b>V</b>	CO2 4.5 Kg (CARBON DIOXIDE TYPE EXTINGUISHER)
10.	•	AFFF 9.0 LTS. (AQUEOUS FILM FORMING FOAM TYPE EXTINGUISHER)
11.	*	PENDENT SPRINKLER

	SIGN.												
	INITIALS												
	REVISIONS												
	SIGN.												
	INITIALS												
	REVISIONS												
	SIGN.												
	INITIALS												
	REVISIONS												
	SIGN.												
	INITIALS												
	REVISIONS												
PO	SIGN.												13-05-2020
	INITIALS	MR	MA	MAM									13-03-2020
ICCLIE			DCN	CLID	CV	EL	IC	ME			DE /DM	A D D D	DATE
ISSUE	DRN		DSN	CHD		CLEARED					PE/PM	APPD	DATE

# FOR TENDER PURPOSE ONLY

## DO NOT SCALE

'P' (PRELIMINARY) ISSUES ARE NOT TO BE USED FOR CONSTRUCTION / FABRICATION BUT ARE ISSUED FOR LIMITED PURPOSES ONLY AS INDICATED IN THE SMALL

CONSTRUCTION / FABRICATION WORK IS PERMITTED ON 'R' (RELEASED) ISSUES ONLY.

INFORMATION CONTAINED WITHIN 'HOLD' IS NOT RELEASED FOR CONSTUCTION / FABRICATION. FIELD MUST GET DESIGN OFFICE TO CLEAR 'HOLDS' IN TIME BEFORE PROCEEDING WITH ANY CONSTRUCTION / FABRICATION WORK RELATED TO 'HOLDS'.

Proprietary rights of the information contained herein belong to TCE. This information is intended to be used for the mentioned purpose/project only In case of misuse of information and any claim arising thereof, cost and consequence will be on the party misusing the information.

GUWAHATI SMART CITY DEVELOPMENT AGENCY LTD. SMART CITY MISSION GUWAHATI


FOURTH FLOOR FPS LAYOUT



TATA CONSULTING ENGINEERS LIMITED **MUMBAI** 

 SCALE : 1:50

 FILE NAME: 10477A-ME-6041-FF-60105P0.dwg
 DC & DISC: PN-ME

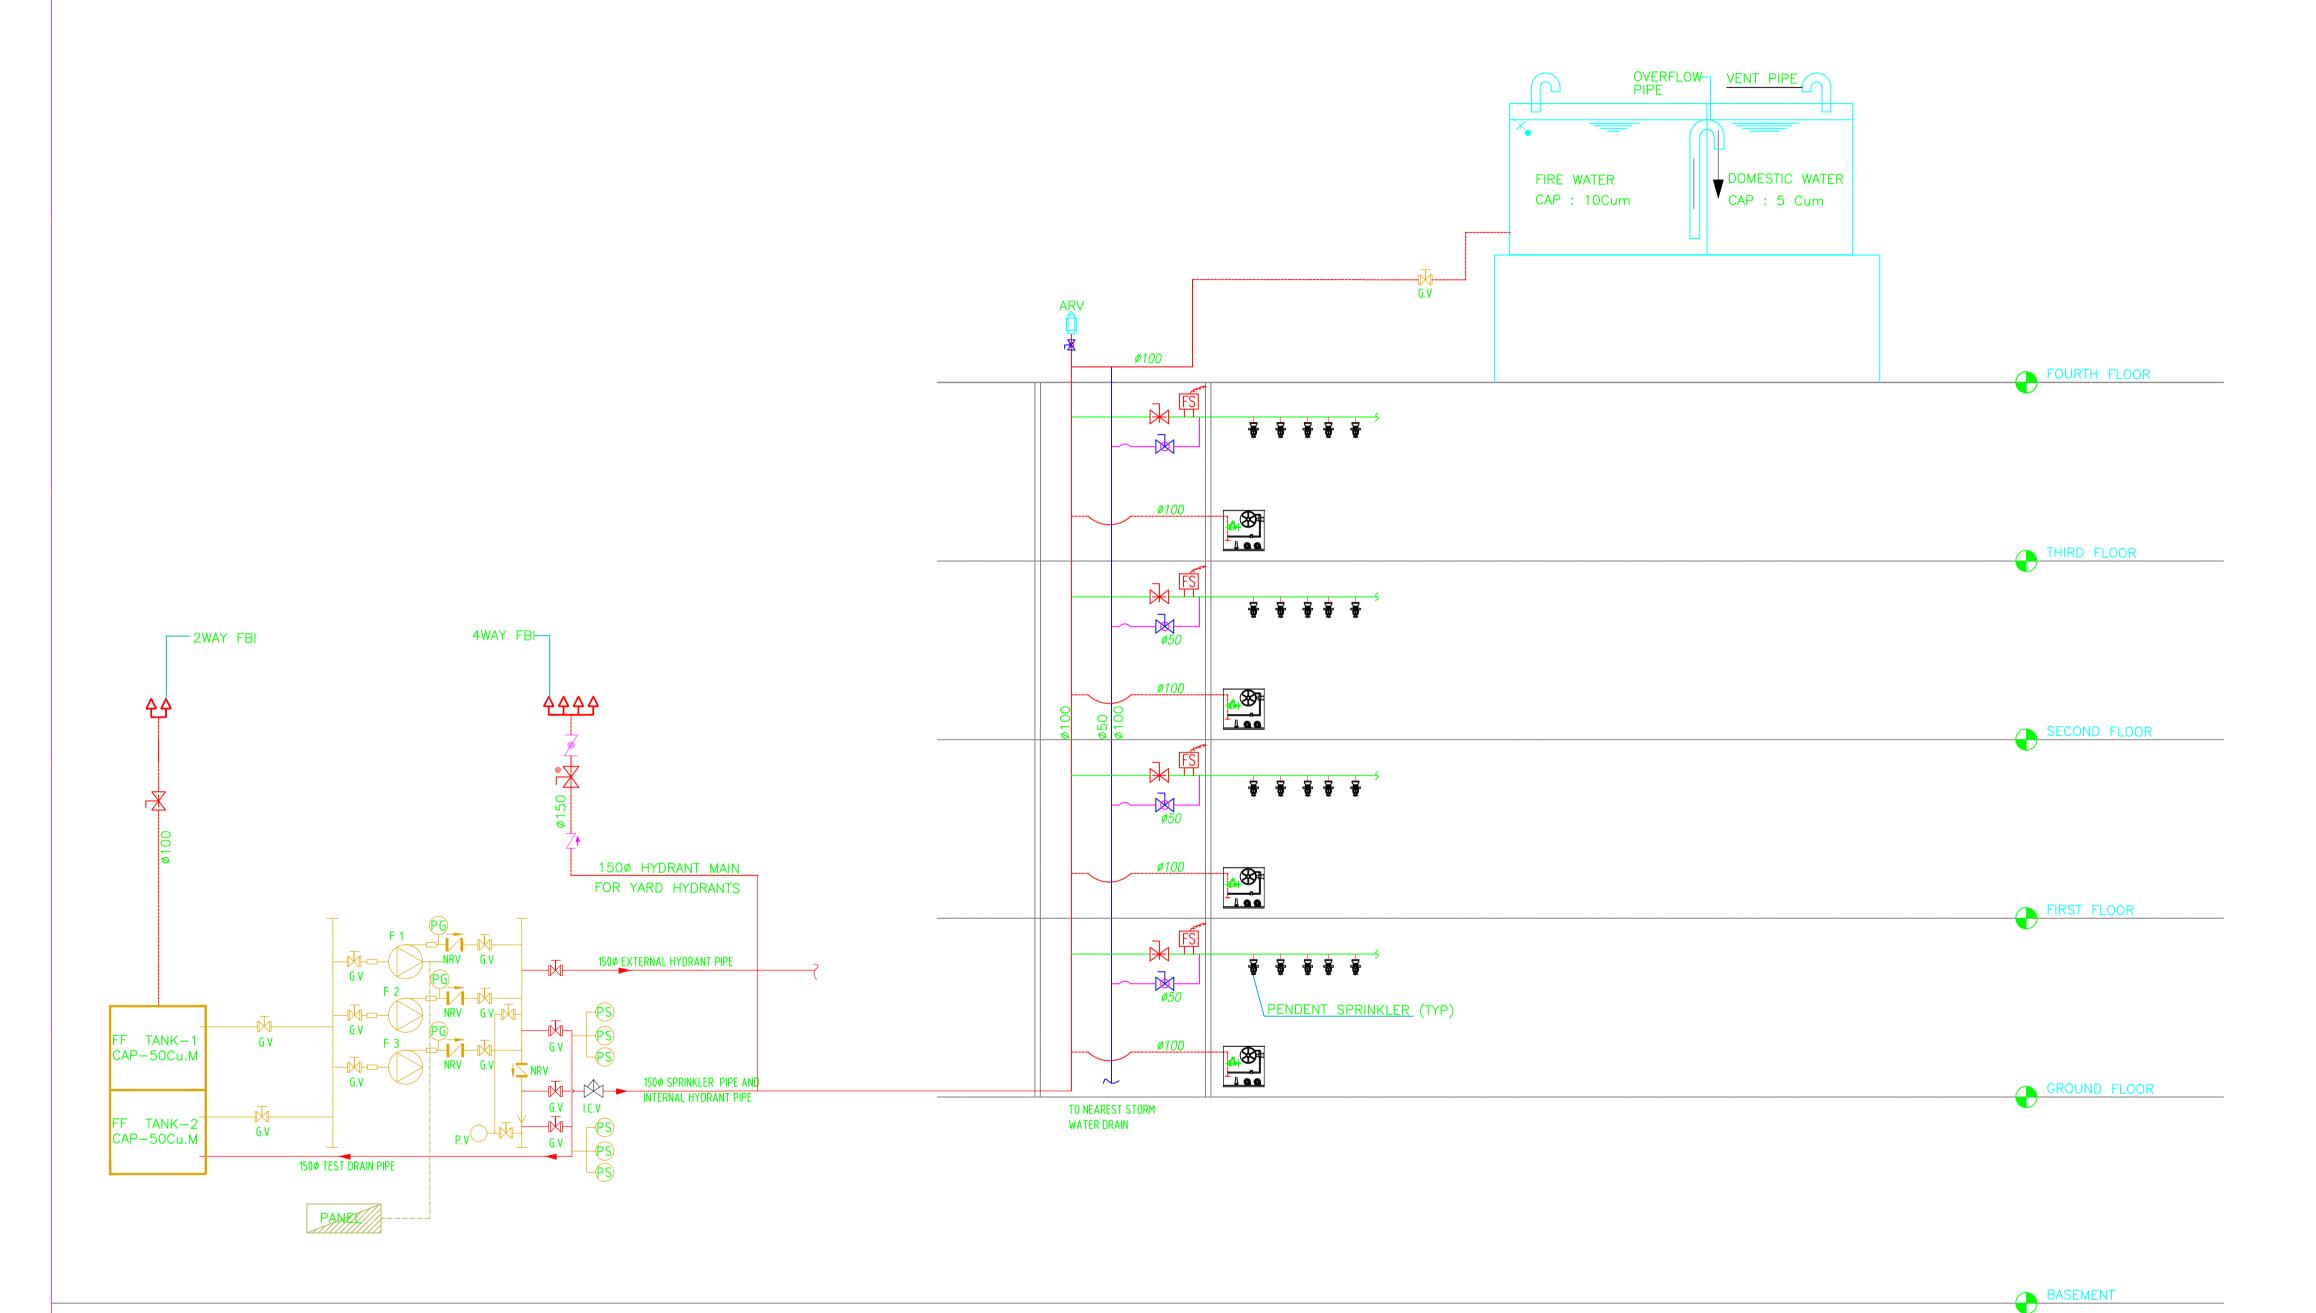

FIRE HYDRANT AND SPRINKLER SCHEMATIC DIAGRAM

	FIRE PUMP DETAI	LS	
	DESCRIPTION	DISCHARGE (LPM)	HEAD (M)
F1	ELECTRICAL MOTOR DRIVEN MAIN FIRE PUMP	2280	70
F2	DIESEL ENGINE DRIVEN STANDBY FIRE PUMP	2280	120
F3	JOCKEY PUMP	180	120

NORTH FOOTPATH FOOTPATH ROAD FRL ±0.0

- ALL DIMENSIONS ARE IN MILLIMETERS UNLESS OTHERWISE STATED.
- 2. THIS DRAWING SHALL BE READ IN CONJUNCTION WITH ARCHITECTURAL, PUBLIC HEALTH, ELECTRICAL AND STRUCTURAL DRAWINGS.
- 3. PIPES SHALL BE HEAVY DUTY GI PIPE CLASS "B" CONFORMING TO IS 1239.
- 4. UNDERGROUND PIPE SHALL BE COATED AND WRAPPED AS PER IS: 10221 WITH "PYPKOTE" WRAPPING COATING MATERIAL OF 4mm THICK.
- 5. SLUICE VALVE SHALL BE CONFORMING TO IS: 780.
- 6. 5. THE DEPTH OF UNDERGROUND PIPE SHALL BE DECIDED AT SITE AS PER THE SITE CONDITION TO AVOID FOULING WITH OTHER SERVICES SUBJECT TO THE TOP OF THE U/G PIPE IS MINIMUM 1M BELOW FROM THE FGL.
- . MINOR CHANGES IN THE PIPE ROUTING SHALL BE MADE TO SUIT SITE LOCATIONS WITHOUT EFFECTING DESIGN ASPECTS.
- 8. MINOR CHANGES IN THE HYDRANT LOCATION SHALL BE MADE TO SUIT MACHINE/ EQUIPMENT REQUIREMENT WITHOUT EFFECTING DESIGN ASPECTS.
- 9. ANY DISCREPANCIES ARE TO BE BROUGHT TO THE ATTENTION OF THE ENGINEER AND RESOLVES AT TENDER STAGE BEFORE COMMENCEMENT OF ANY WORK. NO FURTHER CLAIMS SHALL BE ENTERTAINED THEREAFTER.

### LEGENDS:-

SR. NO.	SYMBOL	DESCRIPTION
1.		1500 GI CLASS 'B' HYDRANT PIPE
2.	<b>₽₽</b>	FIRE HOSE BOX WITH SET OF HOSE
3.	<b>-</b> ∄	BRANCH PIPE & NOZZLE
4.	1 👁	RUBBER FIRE HOSE (ø63mm,2Nos, 15m LENGTH)
5.	<b>T</b>	HOSE REEL, Ø20MM, 30M LONG
6.	1	NON RETURN VALVE
7.		FIRE PUMPS
8.		Y-STRAINER
9.	<b>—</b>	PENDENT SPRINKLER
10.	PG	PRESSURE GUAGE
11.	PS	PRESSURE SWITCH

SIGN. INITIALS REVISIONS INITIALS REVISIONS SIGN. INITIALS REVISIONS INITIALS REVISIONS SIGN. INITIALS

GUWAHATI SMART CITY DEVELOPMENT AGENCY LTD.

SMART CITY MISSION GUWAHATI

HYDRANT AND SPRINKLER SCHEMATIC



TATA CONSULTING ENGINEERS LIMITED **MUMBAI** 

DWG NO. 10477A-ME-6041-FF-60106 ISSUE

FILE NAME: 10477A-ME-6041-FF-60106P0.dwg

FOR TENDER PURPOSE ONLY

DO NOT SCALE

'P' (PRELIMINARY) ISSUES ARE NOT TO BE USED FOR

CONSTRUCTION / FABRICATION BUT ARE ISSUED FOR LIMITED PURPOSES ONLY AS INDICATED IN THE SMALL

(RELEASED) ISSUES ONLY.

WORK RELATED TO 'HOLDS'.


CONSTRUCTION / FABRICATION WORK IS PERMITTED ON 'R'


INFORMATION CONTAINED WITHIN 'HOLD' IS NOT RELEASED FOR CONSTUCTION / FABRICATION. FIELD MUST GET DESIGN OFFICE TO CLEAR 'HOLDS' IN TIME BEFORE PROCEEDING WITH ANY CONSTRUCTION / FABRICATION


Proprietary rights of the information contained herein belong to TCE. This

In case of misuse of information and any claim arising thereof, cost and consequence will be on the party misusing the information.

information is intended to be used for the mentioned purpose

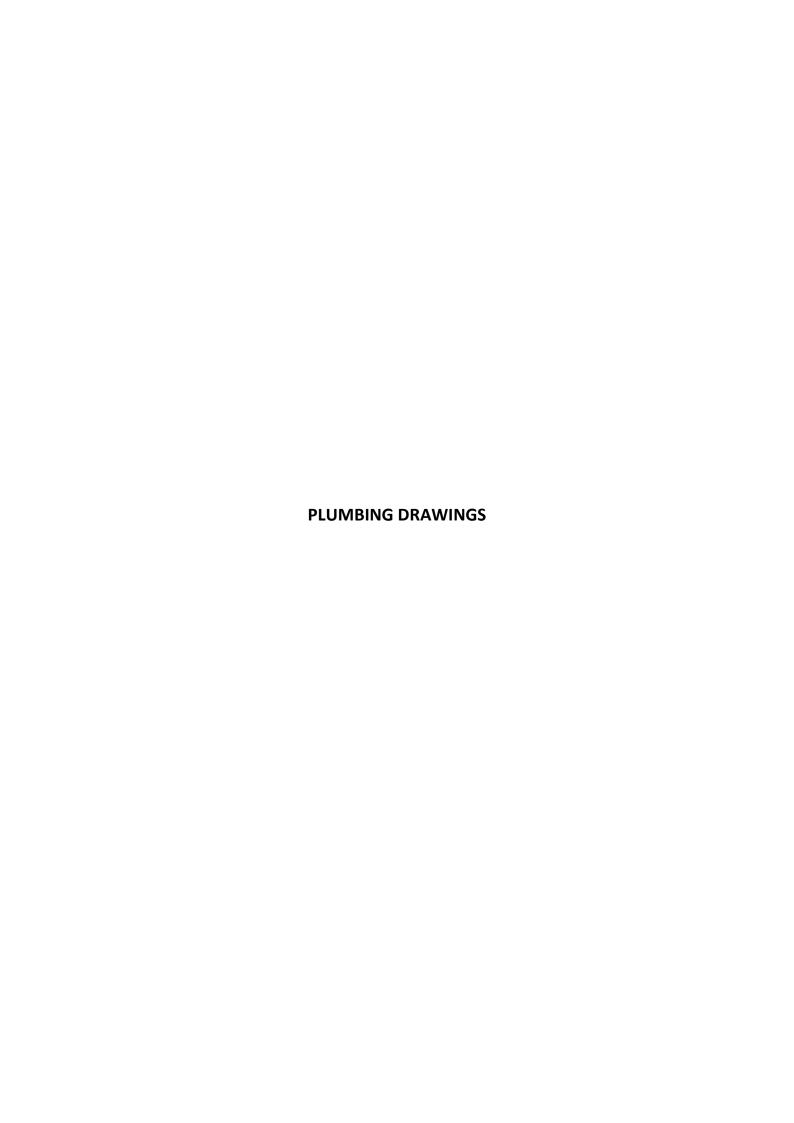

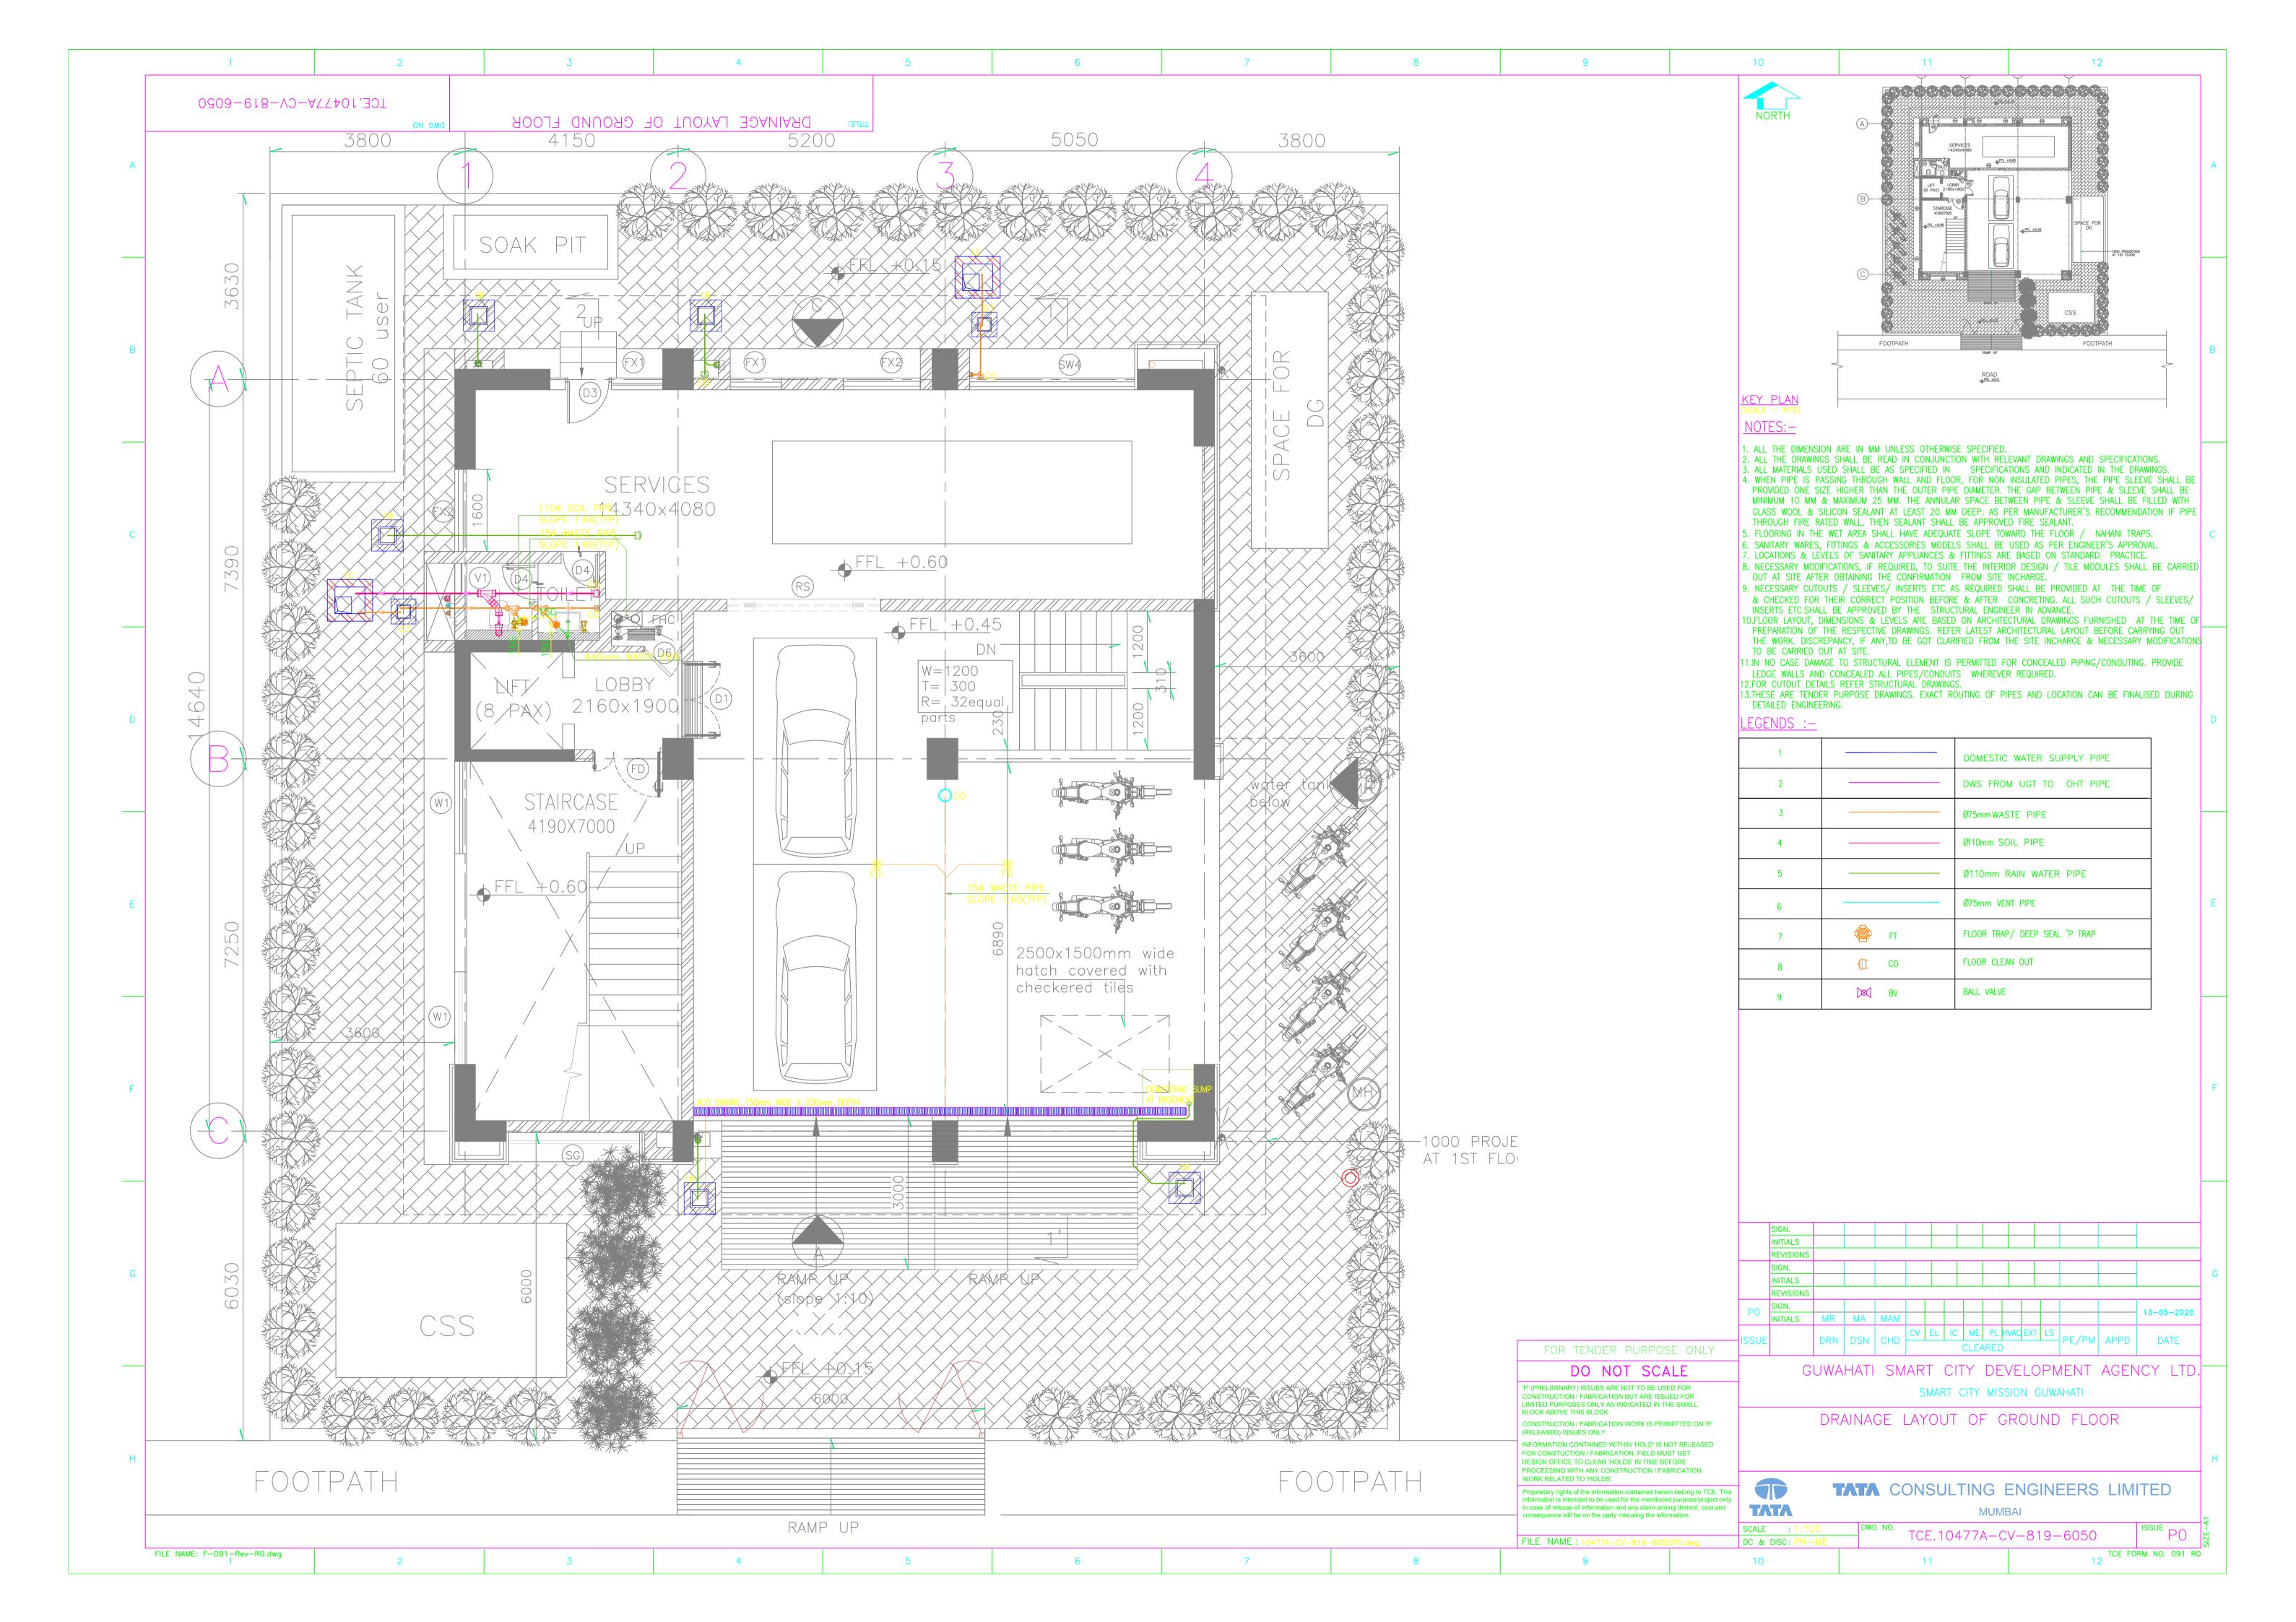


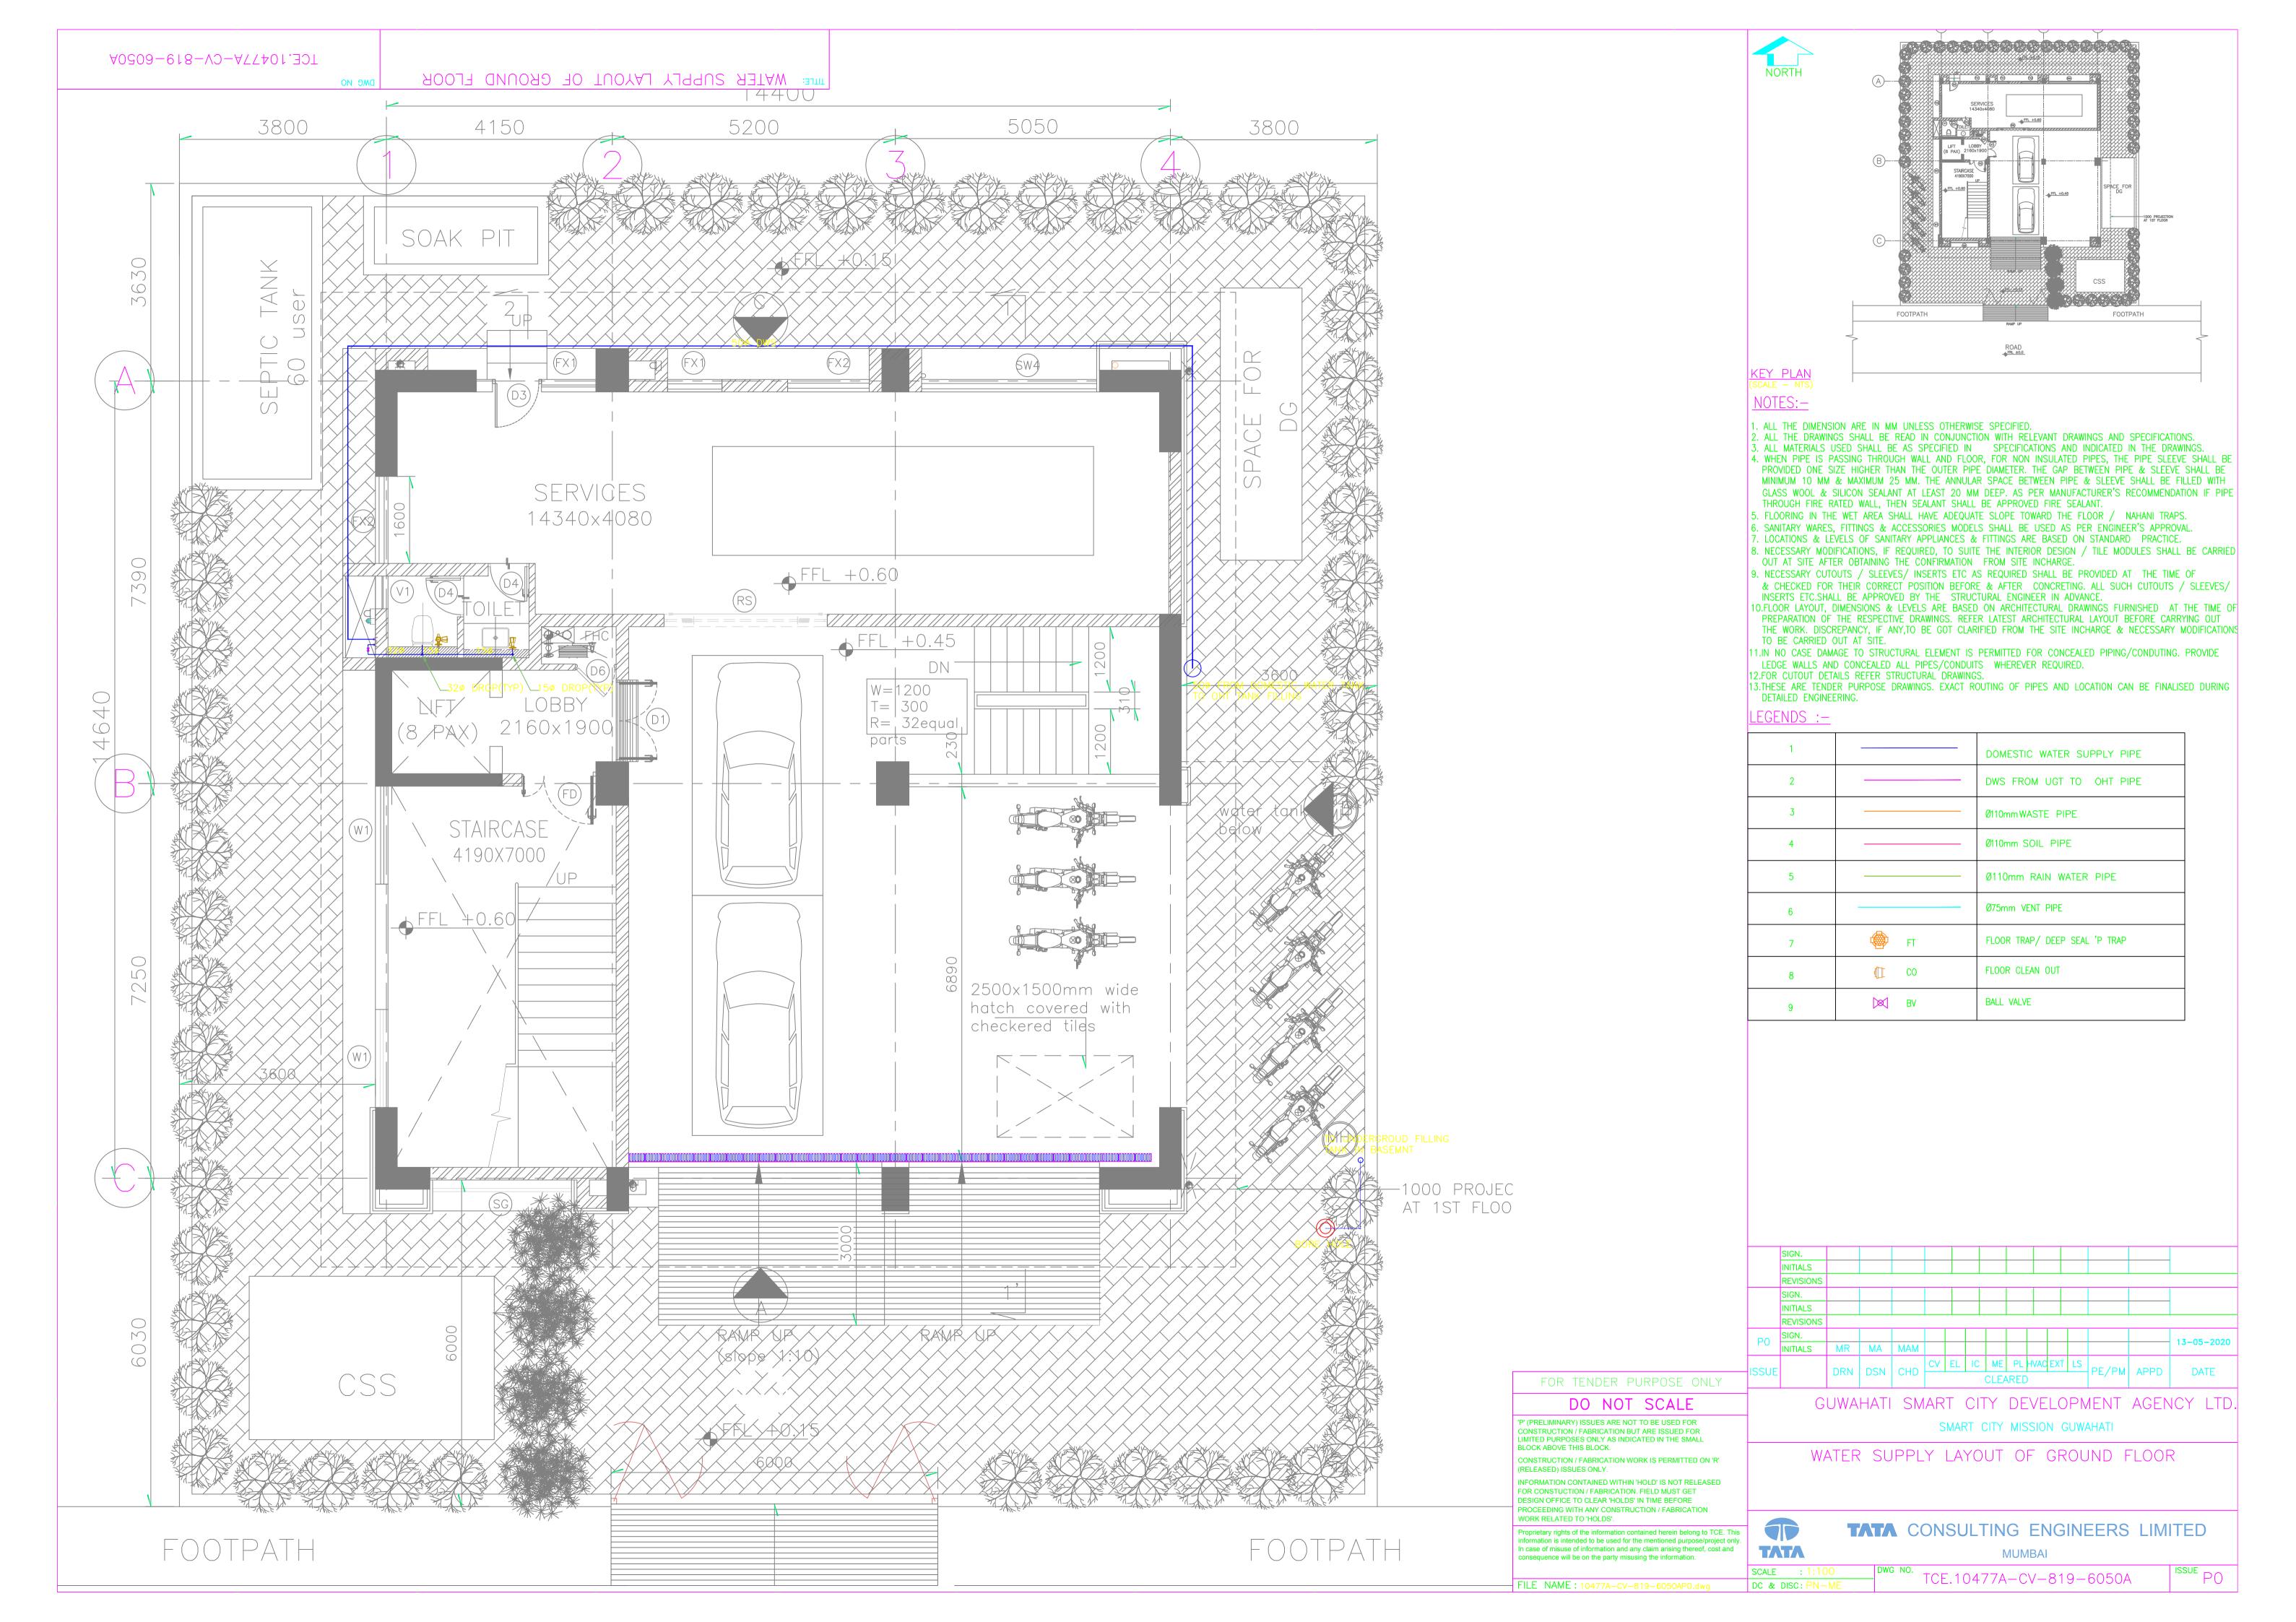

- GLAZING

1ST FLOOR PLAN

1150

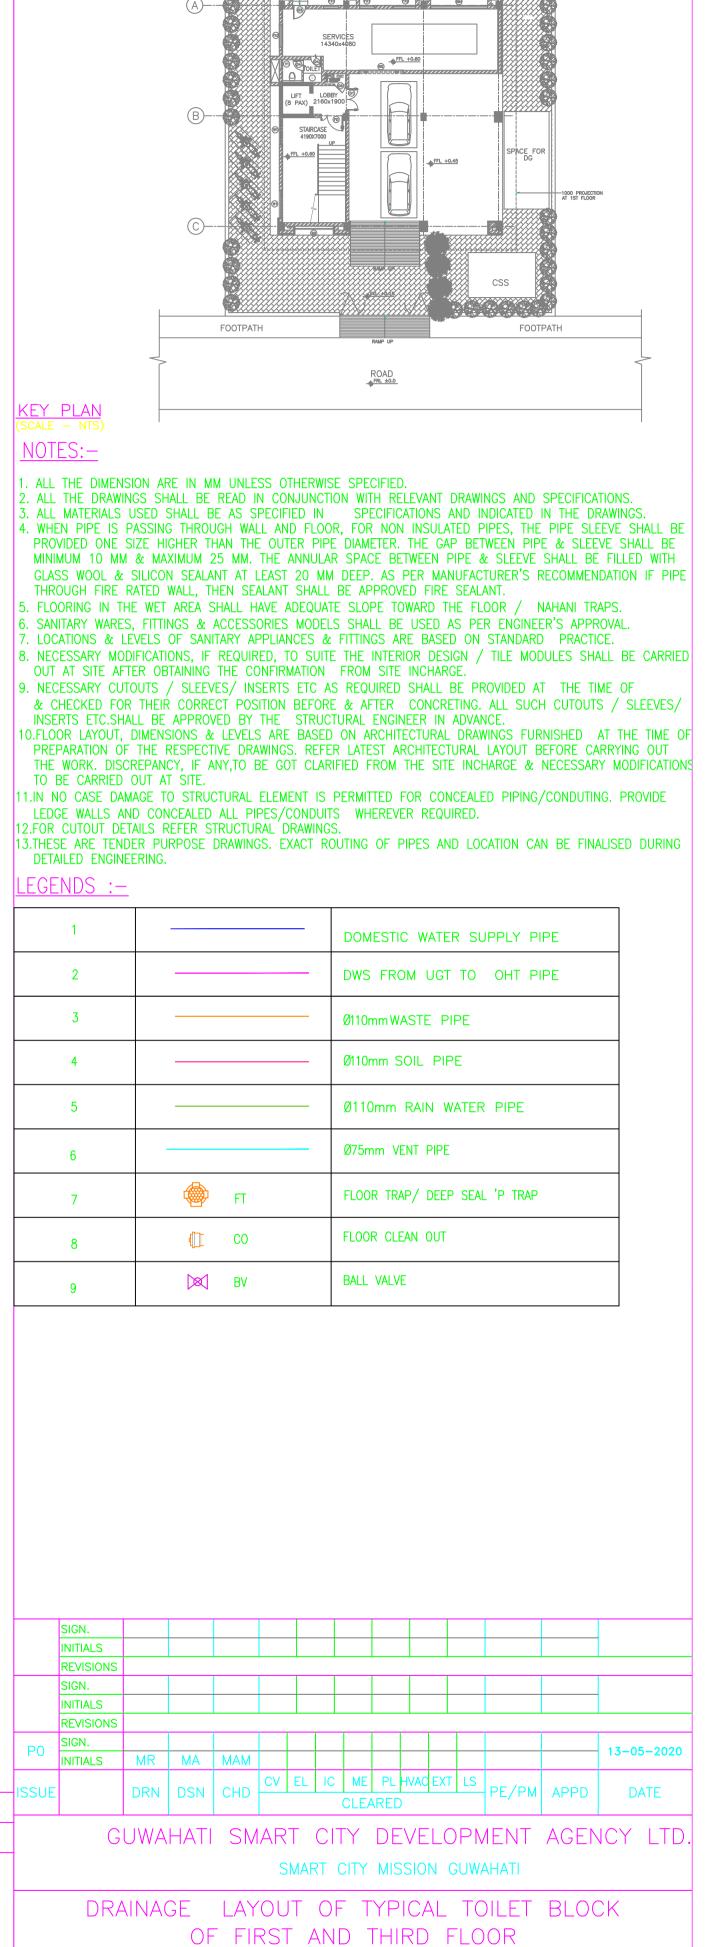

FOR TENDER PURPOSE ONLY

## DO NOT SCALE

'P' (PRELIMINARY) ISSUES ARE NOT TO BE USED FOR CONSTRUCTION / FABRICATION BUT ARE ISSUED FOR LIMITED PURPOSES ONLY AS INDICATED IN THE SMALL BLOCK ABOVE THIS BLOCK.

CONSTRUCTION / FABRICATION WORK IS PERMITTED ON 'R' (RELEASED) ISSUES ONLY.

2100

INFORMATION CONTAINED WITHIN 'HOLD' IS NOT RELEASED FOR CONSTUCTION / FABRICATION. FIELD MUST GET DESIGN OFFICE TO CLEAR 'HOLDS' IN TIME BEFORE PROCEEDING WITH ANY CONSTRUCTION / FABRICATION WORK RELATED TO 'HOLDS'.

TATA

DC & DISC: PN-ME

Proprietary rights of the information contained herein belong to TCE. This information is intended to be used for the mentioned purpose/project only. In case of misuse of information and any claim arising thereof, cost and consequence will be on the party misusing the information.

TATA CONSULTING ENGINEERS LIMITED

MUMBAI

DWG NO. TCE.10477A-CV-819-6051

FILE NAME: 10477A-CV-819-6051P0.dwg